ATTACHMENT J PROJECT PLANS

801 South San Rafael Avenue Pasadena, California 91105

This Old House, LLC 8640 National Boulevard Culver City, California 90232



HILLSIDE DEVELOPMENT PERMIT Re-Submittal September 24, 2020



is Old House, LLC

lau Data la

Date:
Scale: As Shown
Drawn By: MS
Checked By: RR, DR, MR
Architect / Engineer Stamp




Consultants

Cover / Sheet Index

Sheet Number

G000

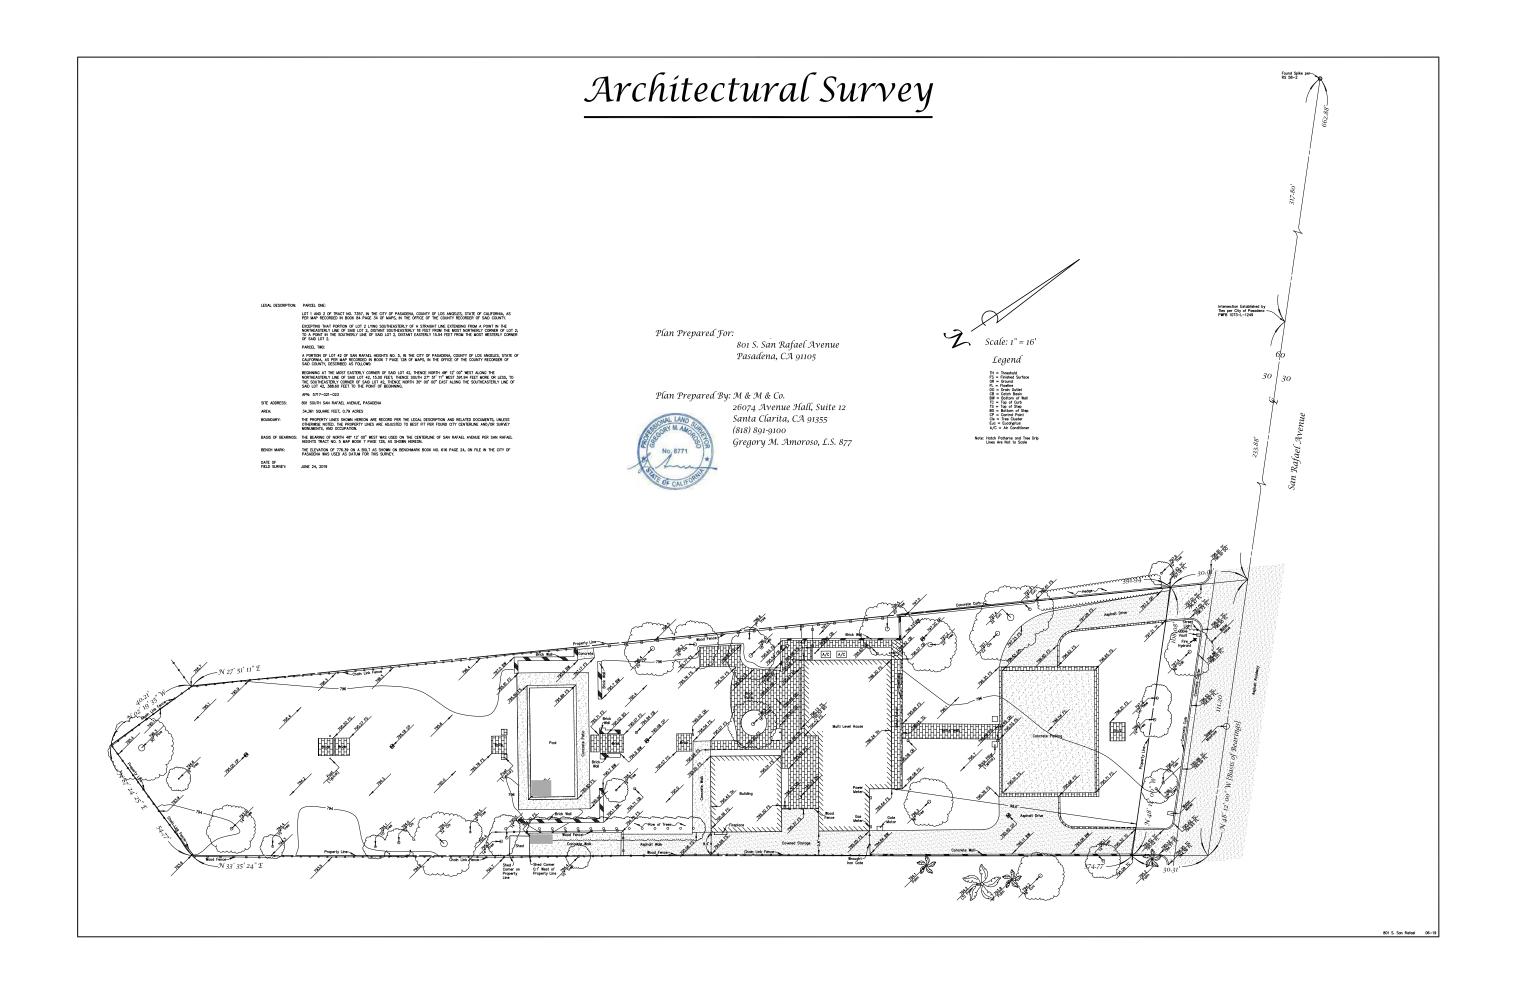




801 South San Rafael Avenue Pasadena, California 91106 This Old House, LLC 8640 National Boulevard, Culver City , California 90232

Aerial Photo

A100

AERIAL PHOTO

 Γ

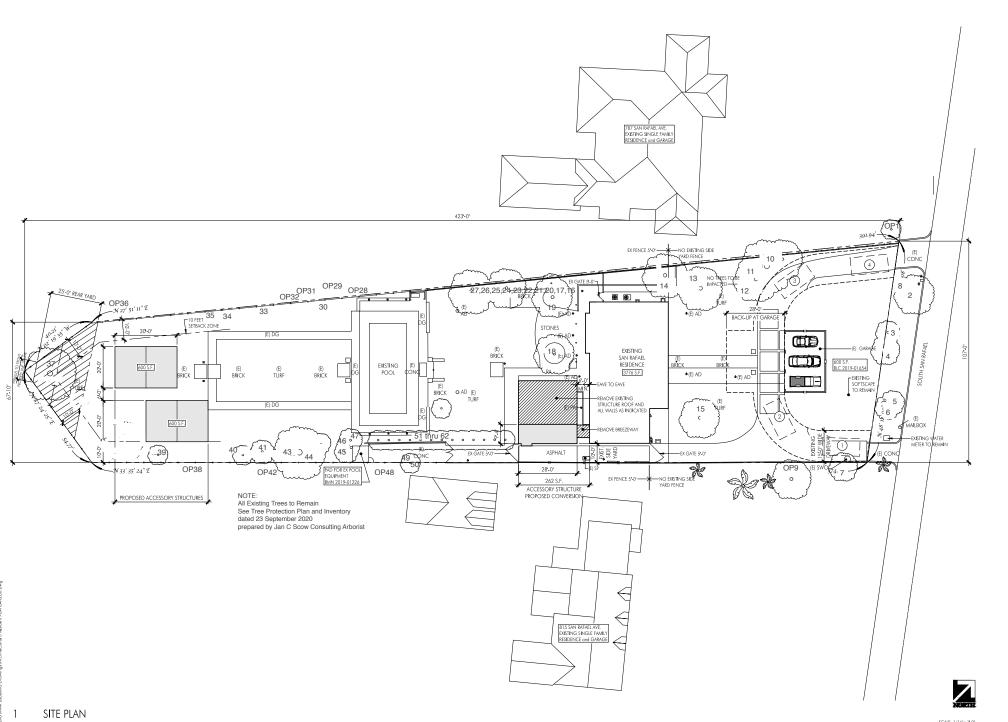

RACHLIN

801 South San Rafael Avenue Pasadena, California 91106 This Old House, LLC 8640 National Boulevard, Culver City, California 90232

Date: Scale: As Shown Drawn By: MS Checked By: RR, DR, MR



Site Plan


1

VICINITY MAP

A101

Building Code Analysis

Building Code Analysis	
construction:	type VB
occupancy group:	r3 single family
zoning:	RS-4HD
lot size:	34,332sf /0.79 acre
front yard setback:	25
side yard setback:	10'
rear yard setback:	25'
existing residence 1st/ floor: (2004+466)(BLD2019-01654)	2,470 sf
existing residence 2nd/ floor	1,306 sf
existing balcony 2nd/ floor	155 sf
existing playroom & breezeway (legacy permit CC12019-01070)	930 sf
total existing floor area w/out accessory (2470+1306+930)	4,760 sf
total existing gross floor area with accessory (2470+1306+930+60	00) 5,306 sf
maximum allowable floor area: (34,332x.25+500)	9,083 sf
existing flaor area to be demolished:	670 sf
existing detached garage (BLD2019-01654)(accessory structure)	600 sf
proposed accessory structure (600+600+260)	1,460 sf
total existing + proposed accessory structure (600 + 1460)	2,060 sf
maximum allowable accessory structure: (34,332 X 6%)	2,062 sf
existing lot coverage: (2470 +930+155+600) 12%	4,155 sf / 34,332 sf
proposed lot coverage: (2470 + 155+2060) 14%	4,687 sf / 34,332 sf
maximum allowable lot coverage: 35%	12,026 sf
existing residence building height:	20-7"
APN:	5717-021-023
enrinblad	0.0

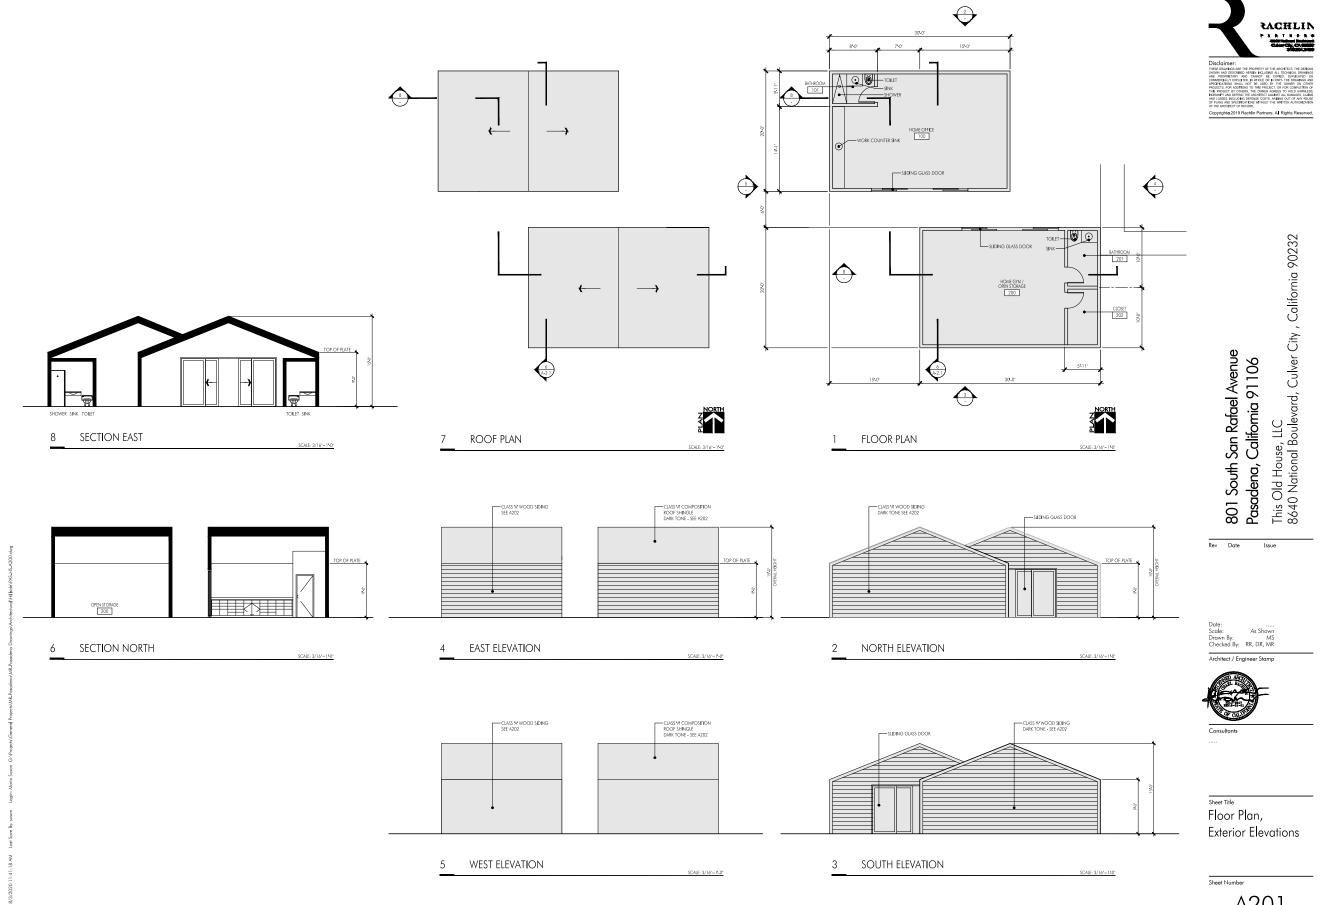


A201

28 20 OPEN PATIO EXISTING INCPERABLE FIREPLACE TO REMAI

2C



CLASS 'A' COMPOSITION ROOF SHINGLE SEE A202 2A NORTH ELEVATION 2B EAST ELEVATION

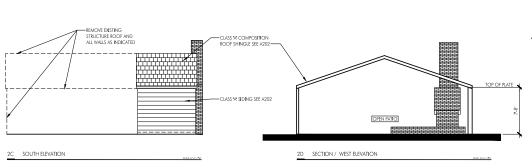

801 South San Rafael Avenue Pasadena, California 91106 This Old House, LLC 8640 National Boulevard, Culver City, California 90232

RACHLIN



Sheet Title Floor Plan, Exterior Elevations

A202

EXTERIOR ELEVATION

PROPSED PLAN






Existing Side Residence Façade | Proposed Accessory to match Roof Slope and Massing



Roof Shingle Proposed to match existing

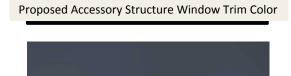

Proposed Accessory Structure Exterior Color



Existing Rear Residence Façade | Proposed Accessory to match Roof Slope and Massing



LISCIGITMEN: THE PROPERTY OF THE ARCHITECT, THE DISCIONAL ARC DECORAGE DEEM NULLINGS ALL TECHNICAL DISCIONAL ARC DECORAGE DEEM NULLINGS ALL TECHNICAL DISCIONAL DISCIPLINA ARC DECORAGE DECORAGE DESCRIPTION OF PART THE PROPERTY OF A PROPERTY OF THE PROPERTY OF A PROPERTY OF THE PROPERTY OF THE PROPERTY OF THE PROPERTY AND CEPTION THE ARCHITECT AGAINST ALL DISMARCS, AND COOSES, PAGINGS OF THE PROPERTY AND COPY AND A PROPERTY OF THE PROPERTY OF T

yright 62019 Rachlin Partners, All Rights Reserved

vard, Culver City , California 90232

801 South San Rafael Avenue Pasadena, California 91106



Consultants

Materials


Sheet Title


A202


Sheet Numb

TREE PROTECTION PLAN

TREE LOCATIONS ARE APPROXIMATE **801 S SAN RAFAEL AVE**

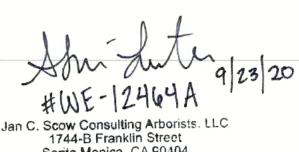

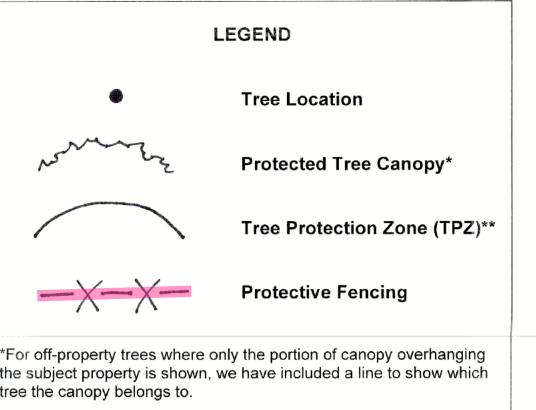

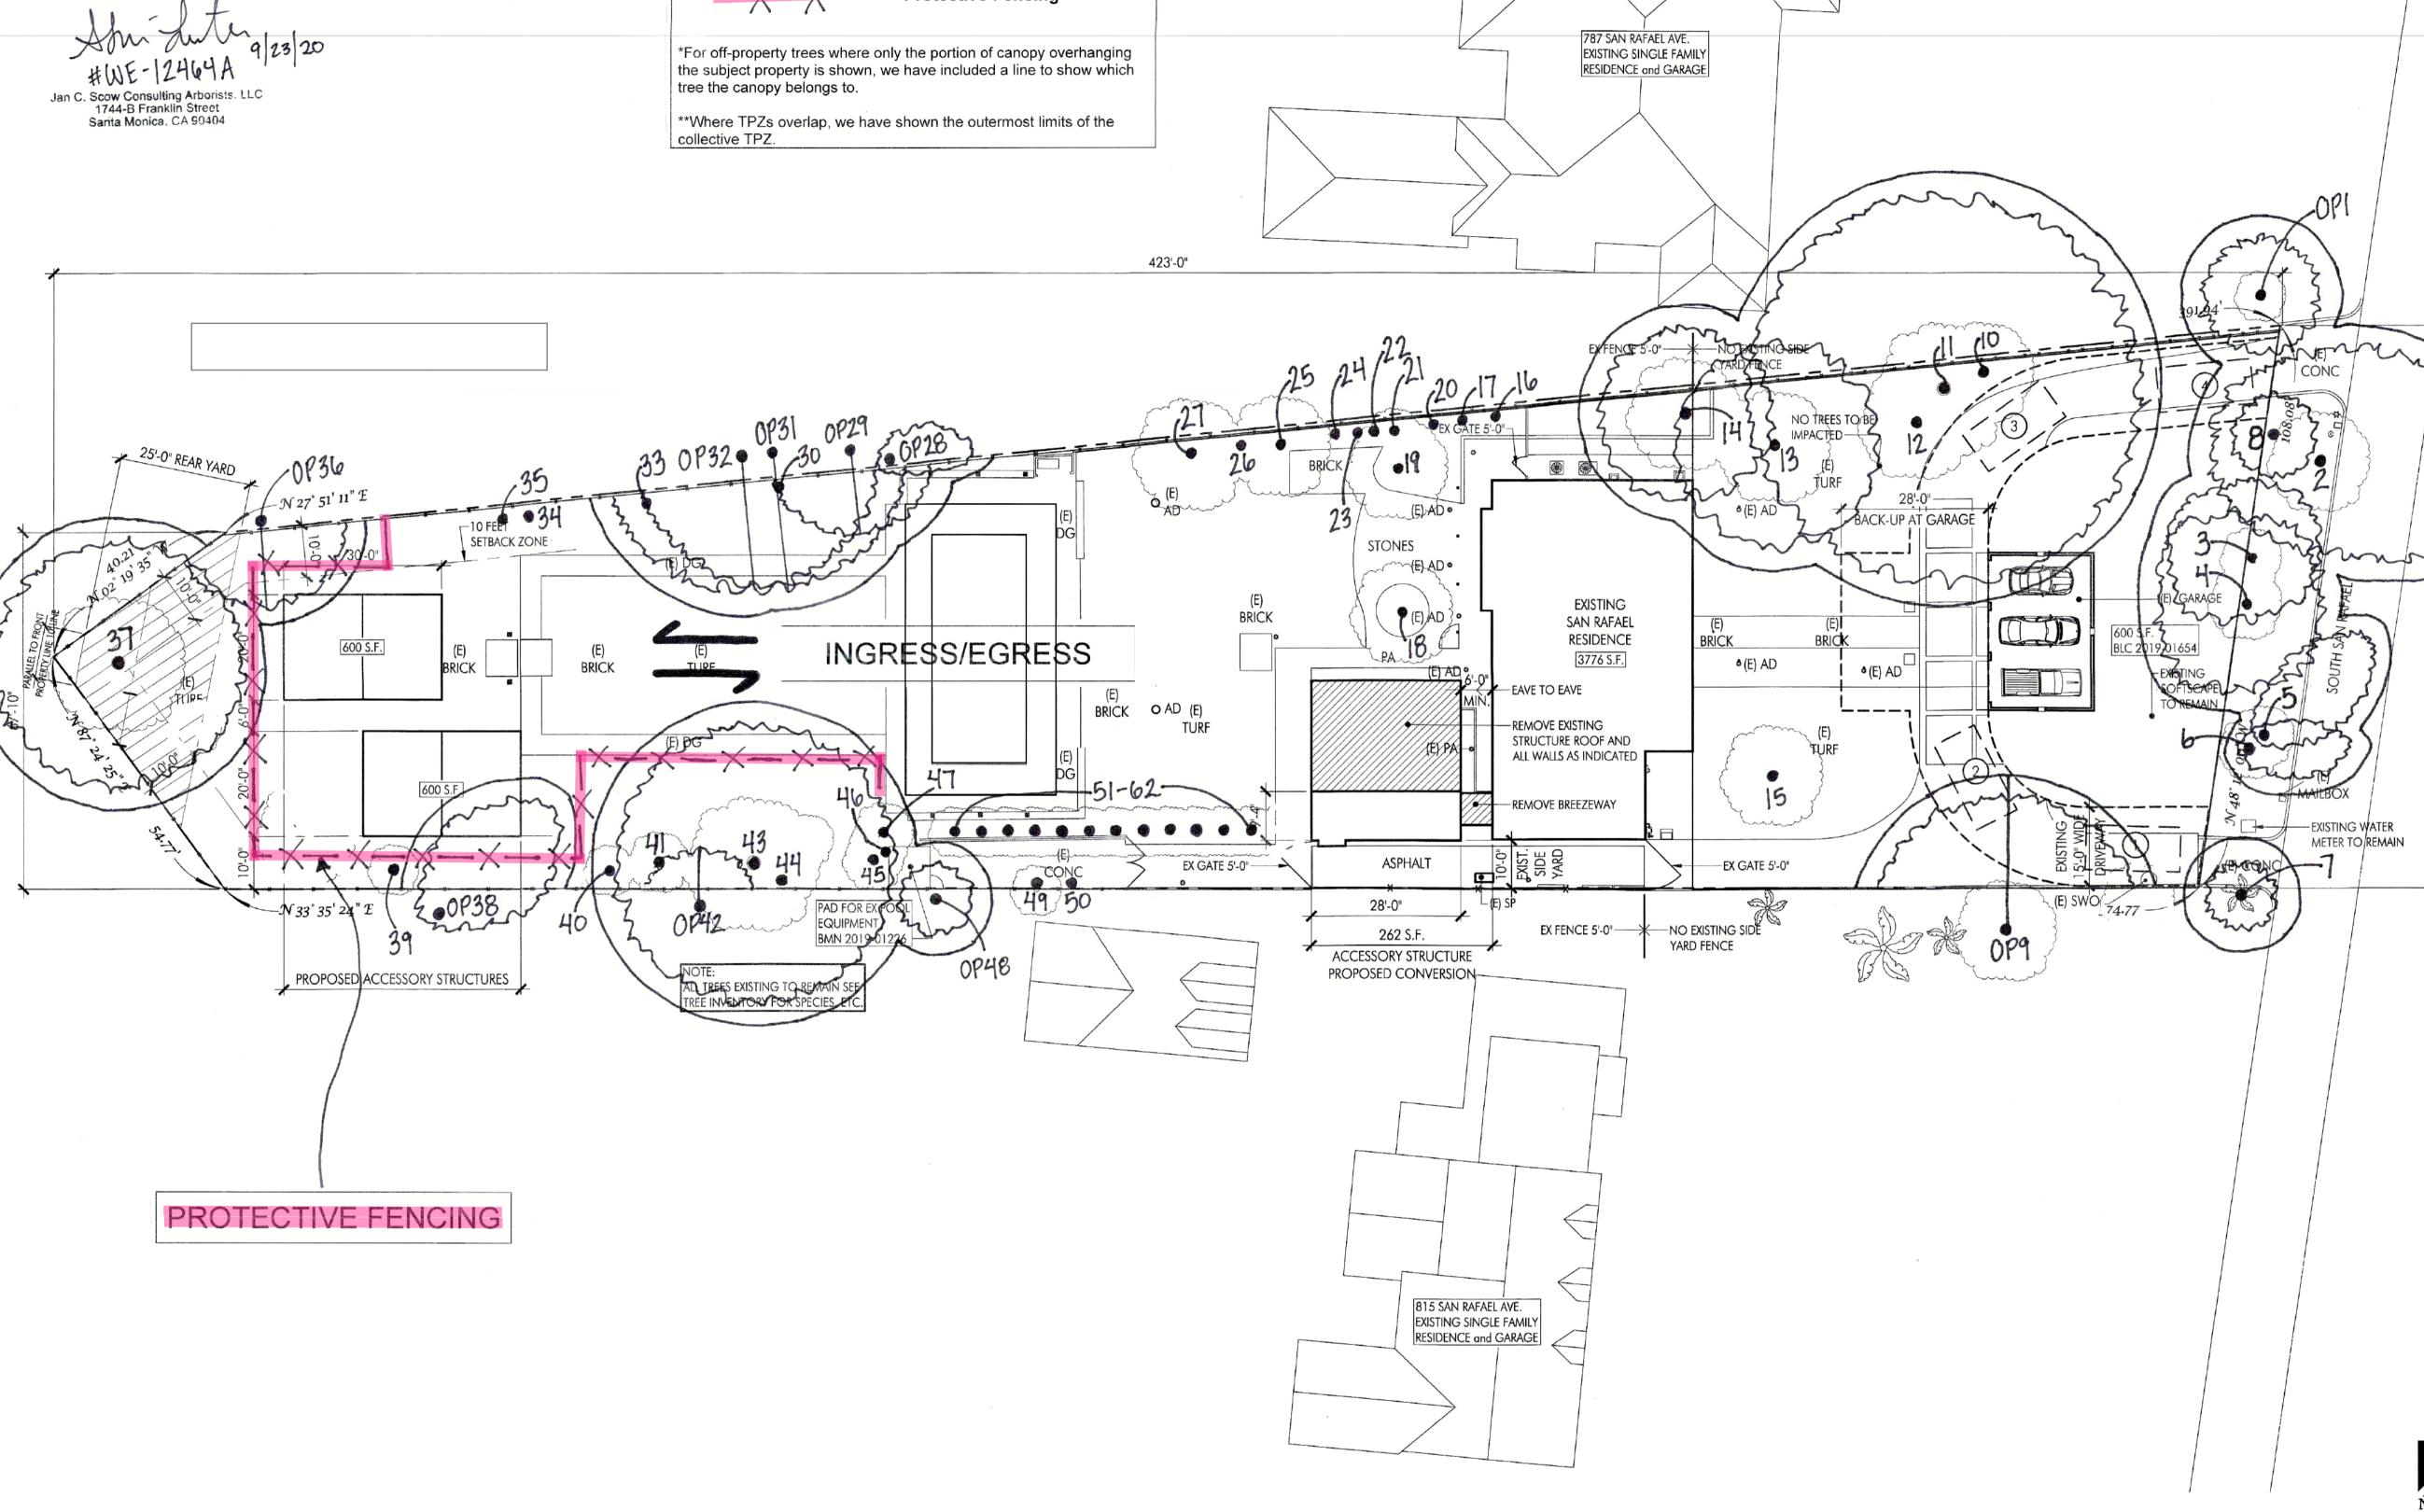

SITE PLAN

SCALE: 1/16"=1'-0"

PROTECTIVE FENCING

"Prior to any construction, tree protections including the installation of fencing to protect all trees on site must be in place. The fencing material shall be chain-link attached to posts inserted into the ground at the edge of the dripline and shall be a minimum of 6' in height. See Standard Plan S-642 (8/24/18) - Tree Protection Chain Link Fencing Fencing shall maintain visual lines of sight in order to avoid vehicle and pedestrian hazards. Fencing shall include a minimum 8.5" x 11" warning sign with the following information: 'Tree Protection Zone'; name and contact information of project owner or authorized representative; 'Please contact the City of Pasadena Citizen Service Center to report any concerns (626) 744-7311'. All protective fencing must be permitted, inspected and approved by Public Works prior to the commencement of any construction."

ARBORIST OVERSIGHT

- The Project Arborist shall be notified at least 72 hours before:
- the property is to be cleared or graded;
- any digging, excavating, trenching, or building within the TPZ of a protected tree on the site commences;
- any pruning of a protected tree's canopy or roots takes place; commencement of any other activity within the TPZ of a protected tree on the site.

Please refer to the enclosed City of Pasadena Tree Protection Guidelines (revised 5/13/19) for further information regarding the protection of trees during root and canopy pruning.

INGRESS AND EGRESS

We have indicated best ingress and egress for the project area at the rear of the site. Access to and from the rear project area for all equipment and personnel shall be limited to the center yard area.

ROOT AND CANOPY PRUNING

The proposed project is not expected to require canopy pruning of any protected trees, but minor root pruning of Trees OP36, 37, and OP38 may be necessary to accommodate the foundations of the proposed accessory structures. The Project Arborist must be consulted prior to root pruning of any protected tree. All root pruning shall conform to ANSI A-300 standards at a minimum.

Please refer to the enclosed City of Pasadena Tree Protection Guidelines (revised 5/13/19) for further information regarding the protection of trees during root pruning.

TREE INVENTORY FOR PROPERTY LOCATED AT 801 S San Rafael Avenue, Pasadena, CA 91105 (For hillside projects include all trees with a diameter of 4 inches or more. For all other projects, include all trees with a diameter of 8 inches or more.) Application may not be processed if Tree Inventory is not completed or if left blank. If no trees exist on site indicate "NONE"

Tree # ¹	Scientific Name Common Name	DBH ² (inches)	Height ³ (feet)	Spread (NESW)	Proposed Status X = Remove R = Remain L = Relocate	S ⁴	Street tree of trees Y = Yes, N U = Unkr
OP1*	Platanus x hispanica London plane	~9	40	10r	R	_	N
2*	Quercus agrifolia coast live oak	21	30	25/25/17/20	R	N	Y
3*	Liquidambar styraciflua American sweetgum	13	45	14/11/15/15	R	-	Y
4*	Liquidambar styraciflua American sweetgum	17	55	15/15/18/18	R	_	Y
5*	Quercus agrifolia coast live oak	14.5	20	25N	R	N	Υ
6*	Olea europaea	15	25	18NE	R	s	Y
7*	olive Washingtonia robusta	15	60 BTF	6r	R	_	Y
8*	Mexican fan palm Chamaerops humilis	6,6,6,6,6+	8 BTF	7r	R		Y
OP9*	Mediterranean fan palm Corymbia citriodora						
	lemon-scented gum Corymbia citriodora	~18	55	24r	R		N
10*	lemon-scented gum Corymbia citriodora	~18	60	21r	R	_	N
11	lemon-scented gum Xylosma congesta	32	55	35r	R	S	N
12	xylosma	8,8,6	20	20r	R	_	N
13	Liquidambar styraciflua American sweetgum	24	55	18r	R	s	N
14	Ulmus parvifolia Chinese elm	20 @ 4'	40	15r	R	s	N
15	Liquidambar styraciflua American sweetgum	19	45	9r	R		N
16	Ficus microcarpa Indian laurel fig	5	10	4r	R	_	N
17	Ficus microcarpa Indian laurel fig	5	12	5r	R	_	N
18	Ulmus parvifolia Chinese elm	19	50	25r	R	_	N
19	Ulmus parvifolia	18	40	25r	R	_	N
20	Chinese elm Podocarpus henkelii	5 @ 3.5'	12	3r	R	_	N
21	long-leafed yellowwood Ficus microcarpa	7	15	6r	R	_	N
22	Indian laurel fig Ficus microcarpa						-
	Indian laurel fig Ficus microcarpa	4	15	5r	R		N
23	Indian laurel fig Podocarpus henkelii	6	18	6r	R		N
24	long-leafed yellowwood Pittosporum tobira	5	20	3r	R		N
25	tobira	6,4+	15	10r	R	_	N
26	Chamaerops humilis Mediterranean fan palm	6,6+	13 BTF	15SE	R	_	N
27	Callistemon viminalis weeping bottlebrush	7,7,6+	15	14r	R	_	N
OP28*	Ficus microcarpa Indian laurel fig	~7	18	15NNE	R		N
OP29*	Ulmus parvifolia Chinese elm	~9	30	15SE	R	_	N
30	Acca sellowiana pineapple guava	3,2,2+	12	7r	R	_	N
OP31*	Fraxinus uhdei shamel ash	>25	60	24SE	R	м	N
OP32*	Fraxinus uhdei shamel ash	>25	60	24SE	R	м	N
33	Lagerstroemia indica	4.5	18	8r	R	_	N
34	crape myrtle Lagerstroemia indica	4	18	8r	R		N
35	crape myrtle unknown fruit tree species	4,4	15	5r	R		N
OP36*	unknown fruit tree species Ulmus parvifolia	>30 @ grade	35	15SE	R	s	N
37	Chinese elm Pinus canariensis	32	75	22r	R	s	N
OP38*	Canary Island pine Pinus halepensis	>25	-				
	Aleppo pine Prunus caroliniana		75	28N	R	S	N
39	Carolina cherry Prunus caroliniana	10 @ 4'	25	23W	R	_	N
			1	l			
40	Carolina cherry	5	25	108	R	_	N
41	Carolina cherry Carya illinoensis pecan	5 11.5	25 30	10S 30W	R R	<u>-</u>	N N
	Carolina cherry Carya illinoensis pecan Eucalyptus polyanthemos silver dollar gum					<u>-</u> -	
41	Carolina cherry Carya illinoensis pecan Eucalyptus polyanthemos silver dollar gum Morus alba white mulberry	11.5	30	30W	R	— — — M	N
41 OP42*	Carolina cherry Carya illinoensis pecan Eucalyptus polyanthemos silver dollar gum Morus alba	11.5	30 40	30W , 10NW	R R		N N
41 OP42* 43	Carolina cherry Carya illinoensis pecan Eucalyptus polyanthemos silver dollar gum Morus alba white mulberry Fraxinus uhdei	11.5 ~18 25 @ 18"	30 40 28	30W , 10NW 25 r	R R R	м	N N N
41 OP42* 43	Carolina cherry Carya illinoensis pecan Eucalyptus polyanthemos silver dollar gum Morus alba white mulberry Fraxinus uhdei shamel ash Fraxinus uhdei shamel ash Fraxinus uhdei	11.5 ~18 25 @ 18"	30 40 28 35	30W , 10NW 25r 6r	R R R	М	N N N N
41 OP42* 43 44 45	Carolina cherry Carya illinoensis pecan Eucalyptus polyanthemos silver dollar gum Morus alba white mulberry Fraxinus uhdei shamel ash Fraxinus uhdei shamel ash Fraxinus uhdei shamel ash Fraxinus uhdei shamel ash Fraxinus uhdei	11.5 ~18 25 @ 18" 6 16	30 40 28 35 50	30W , 10NW 25r 6r 15r	R R R R	M —	N N N N N N N
41 OP42* 43 44 45 46	Carolina cherry Carya illinoensis pecan Eucalyptus polyanthemos silver dollar gum Morus alba white mulberry Fraxinus uhdei shamel ash Washingtonia robusta	11.5 ~18 25 @ 18" 6 16 15	30 40 28 35 50	30W , 10NW 25r 6r 15r	R R R R R	M —	N N N N N N N
41 OP42* 43 44 45 46 47 OP48*	Carolina cherry Carya illinoensis pecan Eucalyptus polyanthemos silver dollar gum Morus alba white mulberry Fraxinus uhdei shamel ash Fraxinus uhdei shamel ash Fraxinus uhdei shamel ash Fraxinus uhdei shamel ash Washingtonia robusta Mexican fan palm Fraxinus uhdei	11.5 ~18 25 @ 18" 6 16 15 13	30 40 28 35 50 55 50 45 BTF	30W , 10NW 25r 6r 15r 15r 15r 6r	R R R R R R	M	N N N N N N N N N N N N N N N N N N N
41 OP42* 43 44 45 46 47 OP48* 49	Carolina cherry Carya illinoensis pecan Eucalyptus polyanthemos silver dollar gum Morus alba white mulberry Fraxinus uhdei shamel ash Fraxinus uhdei	11.5 ~18 25 @ 18" 6 16 15 13 15	30 40 28 35 50 55 50 45 BTF	30W , 10NW 25r 6r 15r 15r 15r 10r	R R R R R R R	M	N N N N N N N N N N N N N N N N N N N
41 OP42* 43 44 45 46 47 OP48* 49 50	Carolina cherry Carya illinoensis pecan Eucalyptus polyanthemos silver dollar gum Morus alba white mulberry Fraxinus uhdei shamel ash Washingtonia robusta Mexican fan palm Fraxinus uhdei shamel ash	11.5 ~18 25 @ 18" 6 16 15 13 15 10 7	30 40 28 35 50 55 50 45 BTF 30 35	30W , 10NW 25r 6r 15r 15r 15r 10r 15SE	R R R R R R R R	M — — — — — — — — — — — — — — — — — — —	N N N N N N N N N N N N N N N N N N N
41 OP42* 43 44 45 46 47 OP48* 49 50 51	Carolina cherry Carya illinoensis pecan Eucalyptus polyanthemos silver dollar gum Morus alba white mulberry Fraxinus uhdei shamel ash Washingtonia robusta Mexican fan palm Fraxinus uhdei shamel ash Fraxinus uhdei shamel ash Fraxinus uhdei	11.5 ~18 25 @ 18" 6 16 15 13 15 10 7 9 @ 3.5'	30 40 28 35 50 55 50 45 BTF 30 35 25	30W , 10NW 25r 6r 15r 15r 15r 15r 6r 10r 15SE	R R R R R R R R	M	X
41 OP42* 43 44 45 46 47 OP48* 49 50 51 52	Carolina cherry Carya illinoensis pecan Eucalyptus polyanthemos silver dollar gum Morus alba white mulberry Fraxinus uhdei shamel ash Mexican fan palm Fraxinus uhdei shamel ash Fraxinus uhdei shamel ash Afrocarpus gracilior fern pine Afrocarpus gracilior fern pine	11.5 ~18 25 @ 18" 6 16 15 13 15 10 7 9 @ 3.5' 8 @ 3.5'	30 40 28 35 50 55 50 45 BTF 30 35 25	30W , 10NW 25r 6r 15r 15r 15r 15r 6r 10r 15SE 6r 5r	R R R R R R R R R R	M — — — — — — — — — — — — — — — — — — —	N N N N N N N N N N N N N N N N N N N
41 OP42* 43 44 45 46 47 OP48* 49 50 51 52 53	Carolina cherry Carya illinoensis pecan Eucalyptus polyanthemos silver dollar gum Morus alba white mulberry Fraxinus uhdei shamel ash Mexican fan palm Fraxinus uhdei shamel ash Fraxinus uhdei shamel ash Fraxinus uhdei shamel ash Afrocarpus gracilior fern pine Afrocarpus gracilior fern pine Afrocarpus gracilior fern pine	11.5 ~18 25 @ 18" 6 16 15 13 15 10 7 9 @ 3.5' 8 @ 3.5' 8 @ 3.5'	30 40 28 35 50 55 50 45 BTF 30 35 25 25	30W , 10NW 25r 6r 15r 15r 15r 15r 6r 10r 15SE 6r 5r	R R R R R R R R R R	M	X X X X X X X X X X X X X X X X X X X
41 OP42* 43 44 45 46 47 OP48* 49 50 51 52 53 54	Carolina cherry Carya illinoensis pecan Eucalyptus polyanthemos silver dollar gum Morus alba white mulberry Fraxinus uhdei shamel ash Mashingtonia robusta Mexican fan palm Fraxinus uhdei shamel ash Fraxinus uhdei shamel ash Afrocarpus gracilior fern pine	11.5 ~18 25 @ 18" 6 16 15 13 15 10 7 9 @ 3.5' 8 @ 3.5' 8 @ 3.5' 8 @ 3.5'	30 40 28 35 50 55 50 45 BTF 30 35 25 25 25	30W , 10NW 25r 6r 15r 15r 15r 15r 6r 10r 15SE 6r 5r	R R R R R R R R R R R R	M	X X X X X X X X X X X X X X X X X X X
41 OP42* 43 44 45 46 47 OP48* 49 50 51 52 53	Carolina cherry Carya illinoensis pecan Eucalyptus polyanthemos silver dollar gum Morus alba white mulberry Fraxinus uhdei shamel ash Afrocarpus gracilior fern pine	11.5 ~18 25 @ 18" 6 16 15 13 15 10 7 9 @ 3.5' 8 @ 3.5' 8 @ 3.5'	30 40 28 35 50 55 50 45 BTF 30 35 25 25	30W , 10NW 25r 6r 15r 15r 15r 15r 6r 10r 15SE 6r 5r	R R R R R R R R R R	M	X X X X X X X X X X X X X X X X X X X
41 OP42* 43 44 45 46 47 OP48* 49 50 51 52 53 54	Carolina cherry Carya illinoensis pecan Eucalyptus polyanthemos silver dollar gum Morus alba white mulberry Fraxinus uhdei shamel ash Fraxinus uhdei shamel ash Fraxinus uhdei shamel ash Fraxinus uhdei shamel ash Fraxinus uhdei shamel ash Fraxinus uhdei shamel ash Fraxinus uhdei shamel ash Ashingtonia robusta Mexican fan palm Fraxinus uhdei shamel ash Fraxinus uhdei shamel ash Afrocarpus gracilior fern pine	11.5 ~18 25 @ 18" 6 16 15 13 15 10 7 9 @ 3.5' 8 @ 3.5' 8 @ 3.5' 8 @ 3.5'	30 40 28 35 50 55 50 45 BTF 30 35 25 25 25	30W , 10NW 25r 6r 15r 15r 15r 6r 10r 15SE 6r 5r 5r	R R R R R R R R R R R R	M	X X X X X X X X X X X X X X X X X X X
41 OP42* 43 44 45 46 47 OP48* 49 50 51 52 53 54 55	Carolina cherry Carya illinoensis pecan Eucalyptus polyanthemos silver dollar gum Morus alba white mulberry Fraxinus uhdei shamel ash Fraxinus uhdei shamel ash Fraxinus uhdei shamel ash Fraxinus uhdei shamel ash Washingtonia robusta Mexican fan palm Fraxinus uhdei shamel ash Fraxinus uhdei shamel ash Afrocarpus gracilior fern pine Afrocarpus gracilior	11.5 ~18 25 @ 18" 6 16 15 13 15 10 7 9 @ 3.5' 8 @ 3.5' 8 @ 3.5' 8 @ 3.5' 9 @ 3.5'	30 40 28 35 50 55 50 45 BTF 30 35 25 25 25 25 25	30W , 10NW 25r 6r 15r 15r 15r 15r 6r 10r 15SE 6r 5r 5r	R R R R R R R R R R R R R R R R R R R	M	
41 OP42* 43 44 45 46 47 OP48* 49 50 51 52 53 54 55 56	Carolina cherry Carya illinoensis pecan Eucalyptus polyanthemos silver dollar gum Morus alba white mulberry Fraxinus uhdei shamel ash Fraxinus uhdei shamel ash Fraxinus uhdei shamel ash Fraxinus uhdei shamel ash Washingtonia robusta Mexican fan palm Fraxinus uhdei shamel ash Fraxinus uhdei shamel ash Afrocarpus gracilior fern pine Afrocarpus gracilior	11.5 ~18 25 @ 18" 6 16 15 13 15 10 7 9 @ 3.5' 8 @ 3.5' 8 @ 3.5' 9 @ 3.5' 8 @ 3.5' 8 @ 3.5' 8 @ 3.5'	30 40 28 35 50 55 50 45 BTF 30 35 25 25 25 25 25 25	30W , 10NW 25r 6r 15r 15r 15r 6r 10r 15SE 6r 5r 5r 5r	R R R R R R R R R R R R R R	M	N
41 OP42* 43 44 45 46 47 OP48* 49 50 51 52 53 54 55 56 57	Carolina cherry Carya illinoensis pecan Eucalyptus polyanthemos silver dollar gum Morus alba white mulberry Fraxinus uhdei shamel ash Fraxinus uhdei shamel ash Fraxinus uhdei shamel ash Fraxinus uhdei shamel ash Washingtonia robusta Mexican fan palm Fraxinus uhdei shamel ash Fraxinus uhdei shamel ash Afrocarpus gracilior fern pine Afrocarpus gracilior	11.5 ~18 25 @ 18" 6 16 15 13 15 10 7 9 @ 3.5' 8 @ 3.5' 8 @ 3.5' 8 @ 3.5' 9 @ 3.5' 9 @ 3.5' 9 @ 3.5'	30 40 28 35 50 55 50 45 BTF 30 35 25 25 25 25 25 25 25	30W , 10NW 25r 6r 15r 15r 15r 15r 5r 5r 5r 5r	R R R R R R R R R R R R R R R R R R R	M	X
41 OP42* 43 44 45 46 47 OP48* 49 50 51 52 53 54 55 56 57 58	Carolina cherry Carya illinoensis pecan Eucalyptus polyanthemos silver dollar gum Morus alba white mulberry Fraxinus uhdei shamel ash Fraxinus uhdei shamel ash Fraxinus uhdei shamel ash Fraxinus uhdei shamel ash Washingtonia robusta Mexican fan palm Fraxinus uhdei shamel ash Fraxinus uhdei shamel ash Afrocarpus gracilior fern pine Afrocarpus gracilior	11.5 ~18 25 @ 18" 6 16 15 13 15 10 7 9 @ 3.5' 8 @ 3.5' 8 @ 3.5' 8 @ 3.5' 9 @ 3.5' 9 @ 3.5' 9 @ 3.5'	30 40 28 35 50 55 50 45 BTF 30 35 25 25 25 25 25 25 25 25	30W , 10NW 25r 6r 15r 15r 15r 15r 5r 5r 5r 5r 5	R R R R R R R R R R R R R R R R R R R	M	N N N N N N N N N N N N N N N N N N N
41 OP42* 43 44 45 46 47 OP48* 49 50 51 52 53 54 55 56 57 58 59	Carolina cherry Carya illinoensis pecan Eucalyptus polyanthemos silver dollar gum Morus alba white mulberry Fraxinus uhdei shamel ash Fraxinus uhdei shamel ash Fraxinus uhdei shamel ash Fraxinus uhdei shamel ash Fraxinus uhdei shamel ash Fraxinus uhdei shamel ash Mexican fan palm Fraxinus uhdei shamel ash Fraxinus uhdei shamel ash Fraxinus uhdei shamel ash Afrocarpus gracilior fern pine Afrocarpus gracilior fern pine	11.5 ~18 25 @ 18" 6 16 15 13 15 10 7 9 @ 3.5' 8 @ 3.5' 8 @ 3.5' 8 @ 3.5' 9 @ 3.5' 9 @ 3.5' 9 @ 3.5' 9 @ 3.5' 9 @ 3.5' 9 @ 3.5'	30 40 28 35 50 55 50 45 BTF 30 35 25 25 25 25 25 25 25 25 25 25 25 25 25	30W , 10NW 25r 6r 15r 15r 15r 15r 5r 5r 5r 5r 5	R R R R R R R R R R R R R R R R R R R	M	N

¹ Tree number should match number on the site plan. Show tree location on site plan. Include all street trees and trees in public rights-of-way. ² Diameter at breast height (DBH) measured at 4 1/2 feet above the point where the trunk meets the ground.

^a Height is estimated in feet - brown trunk feet (BTF) for palms; spread of canopy is estimated in feet in four compass directions (NESW) or as a radius indicated by r. ⁴ Protection status: N indicates a native tree; S indicates a protected tree of specimen size; L indicates a landmark tree; M indicates a non-native or non-protected tree that is ≥ 19"